SITE PLAN GENERAL NOTES:

- A. Remove all existing vegetation, site improvements, etc. whether or not specifically indicated on the drawings to facilitate the completion of all required new work, unless noted otherwise. Visit the site and verify all quantities and items that are required to be removed prior to submittal of bid/proposal. Such work shall be considered part of the base bid.
  - B. Slope all grades and pavement away from building(s) to provide positive drainage, unless noted otherwise.
  - C. Finish grade at sidewalks, buildings, etc., as required to provide smooth transition to grade.
  - D. Angles indicated are 45 degrees unless noted otherwise.
- E. Remove construction debris from the site as required to maintain clean and safe conditions on a continuing basis for the duration of construction.
- F. Provide expansion joints at a maximum spacing of 20 feet OC and control joints at 5 feet OC at concrete sidewalks unless otherwise noted.
- G. Perform all clearing, grubbing and earthwork in accordance with the Geotechnical report, unless more restrictive requirements exist.
- H. Verify that slopes in the direction of travel will be no greater than 1:20 (5%) at pavement locations prior to installation of pavement. Notify architect immediately for direction on how to address this condition.
- I. Test all proposed imported fill material utilizing a qualified testing agency to verify that it meets all specification requirements prior to placing on site.
- J. Dimensions shown are to outside face of stem walls/foundations unless noted otherwise.
- K. Document original condition of areas that may be disturbed during the course of construction. Restore all areas disturbed by construction, staging,
- etc. prior to project completion. L. All sidewalks at building entryways shall be "keyed" into building slab to
- prevent differential movement.

#### SITE PLAN KEYNOTES:

- 1. Vault location. See consultant drawings for more information.
- 2. Fire-truck turning radius.
- Flagpole.
- 4. Playground equipment and shade structures provided by others. Provide bounding curbs and drainage per civil.
- 5. Phase 1 marquee sign.
- 6. Electrical transformer on 10' square pad per SRP design. 7. SES. See electrical design.
- 8. 4' high steel playground fence, north and east elevations only.
- 9. Line of 8' property easement.
- 11. 8' high painted masonry site wall.
- 12. Trash dumpsters provided by owner.

10. Location of phase 2 marquee sign.

- 13. Roll-curb. See civil design for details.
- 14. 6" dia. steel pipe bollards.
- 15. 1st phase over-excavation zone.
- 16. Grease interceptor location. See plumbing/civil.
- 17. Striped pavement indicating bus/parent drop/fire lane.
- 18. Precast parking bumper. TYP. where no curb is adjacent and at accessible spaces only. See 5C / AS103.
- 19. Sidewalk scupper location.
- 20. ALTERNATE BID: asphalt driveway and parking lane.
- 21. Exterior can-wash sink. See plumbing.
- 22. Booster pump system with clear area. Reference plumbing design.
- 23. Tube-steel column and metal panel roof above.
- 24. Slope concrete in this area away from SES.
- 25. 6" high concrete curb for cane detection. DG area within.
- 26. 4" high concrete housekeeping pad for booster pump. Dimensions: 5'-6" x 9'-2" centered on pump as shown.
- 27. Elevator sump pump daylight here.
- 28. High and Low exterior drinking fountain

#### SITE PLAN LEGEND

MEDIUM BROOM FINISH CONCRETE

ASPHALT PAVEMENT

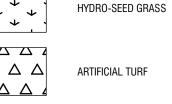


ACCESSIBLE LANE STRIPING

HEAVY SALT FINISH CONCRETE

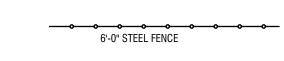


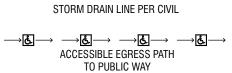
DECOMPOSED GRANITE



ARTIFICIAL TURF

6'-0" CHAIN LINK FENCE





 ${\tt P-P-P-P-P-P-P}$ PAINTED CURB

- SITE LIGHTING PER ELECTRICAL ■ CB CATCH BASIN. SEE CIVIL.
- DW DRY WELL. SEE CIVIL. FIRE LANE SIGN.
- VA VAN ACCESSIBLE H.C. PARKING SIGN. DNE 'DO NOT ENTER' SIGN ADOT DETAIL R5-1.
- FH FIRE HYDRANT. SEE CIVIL DRAWINGS FOR ADDITIONAL INFORMATION.
- PAINTED DIRECTIONAL ARROW ON PAVING.

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2929 n central ave

CONSTRUCTION

the Orcutt (Winslow Partnership and shall remain their property. The design professional shall not be responsible for any alterations, modifications or additions made to this drawing by any party other than the design professional. Use of this drawing shall be limited to the original site for which it was prepared and publication thereof is expressly limited to such use, re-use or reproduction. Unless otherwise agreed in writing, design professional reserves all copyright or other proprietary interest in this drawing, and it may not be re-used for any other purpose without the design professional's written consent. Publication by any method in whole or part is prohibited without the written permission of the design professional. Any information obtained or conclusions derived from this drawing shall be at the user's sole risk.

CLIENT CONTACT

20217 east chandler jlamb2@qcusd.org heights road queen creek, az 85142 DATE OF ISSUE

480-987-5935 t

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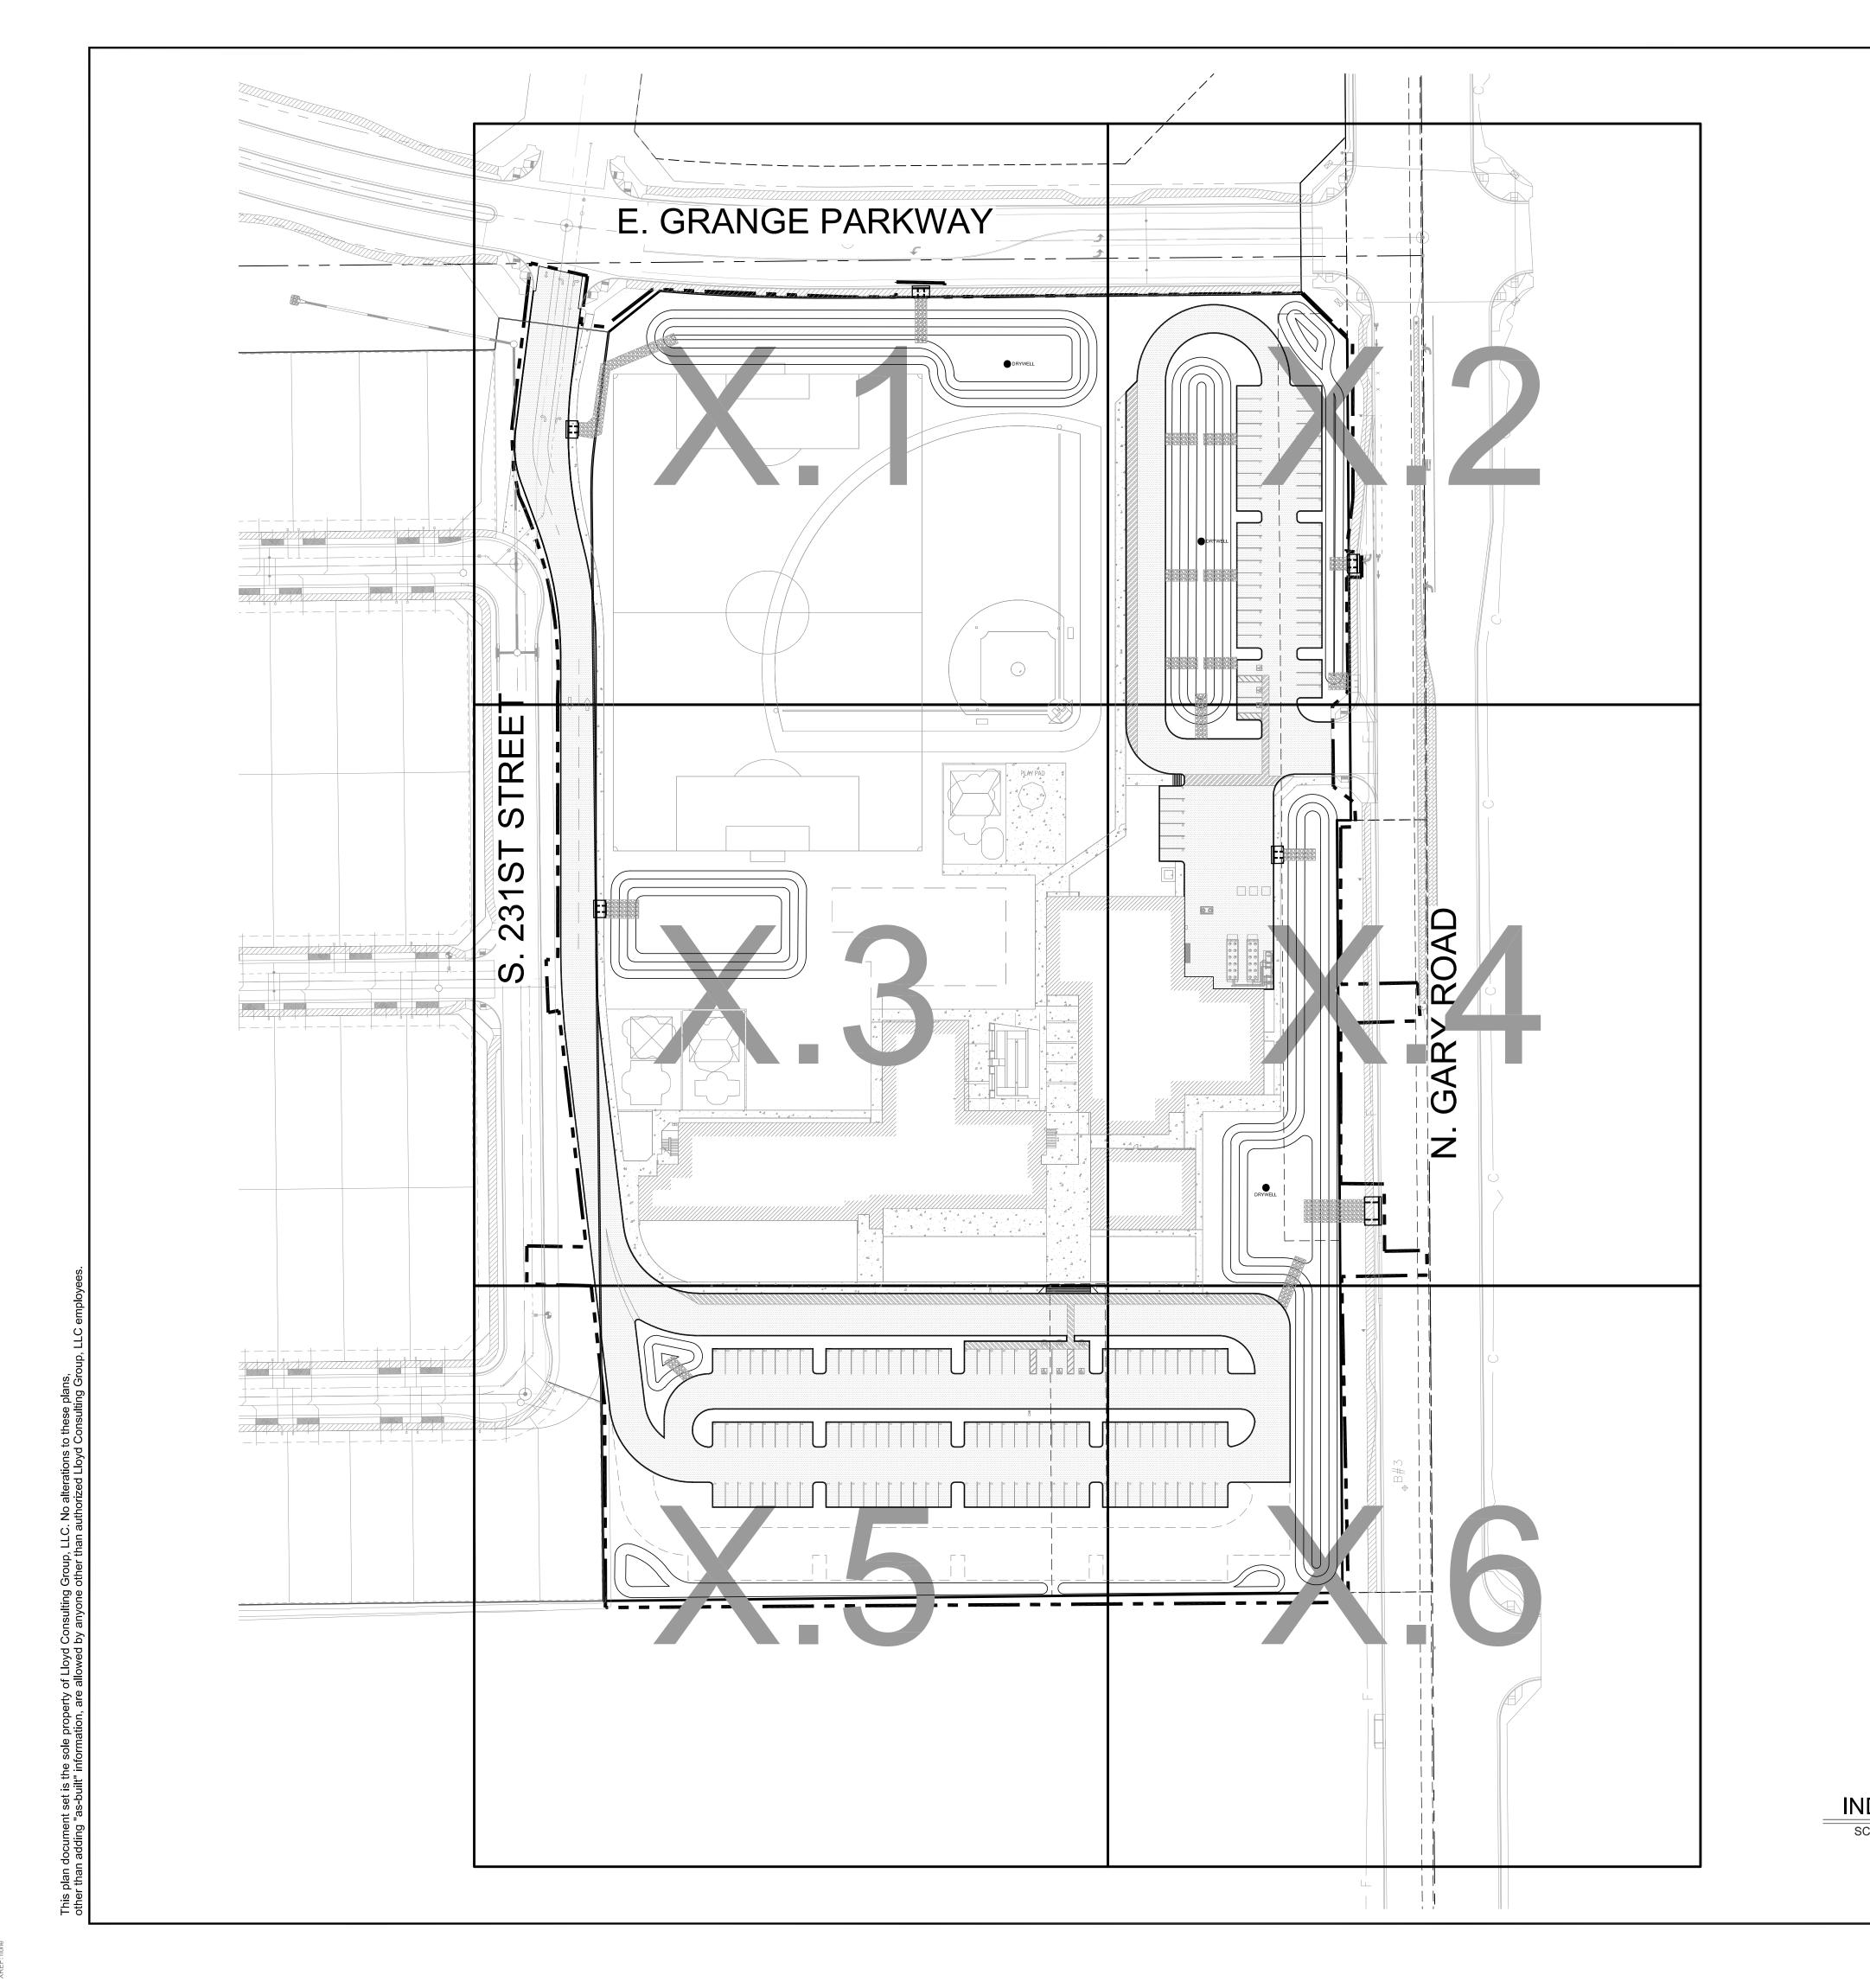


PROJECT TEAM DRAWN BY

PROJECT PHASE construction documents

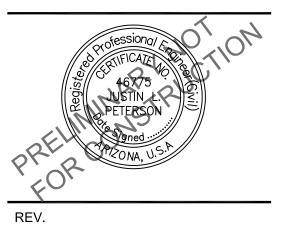
SHEET CONTENTS architectural site plan

SHEET NO. **AS101** 





## FOR PRELIMINARY REVIEW ONLY



#### QUEEN CREEK USD HARVEST SCHOOL

N. GARY ROAD QUEEN CREEK, AZ

DESIGNED:	JLP
DATE:	Aug 31, 2020
DRAWN:	TML
PROJ.	20-137
SCALE:	1" = 60'

INDEX MAP

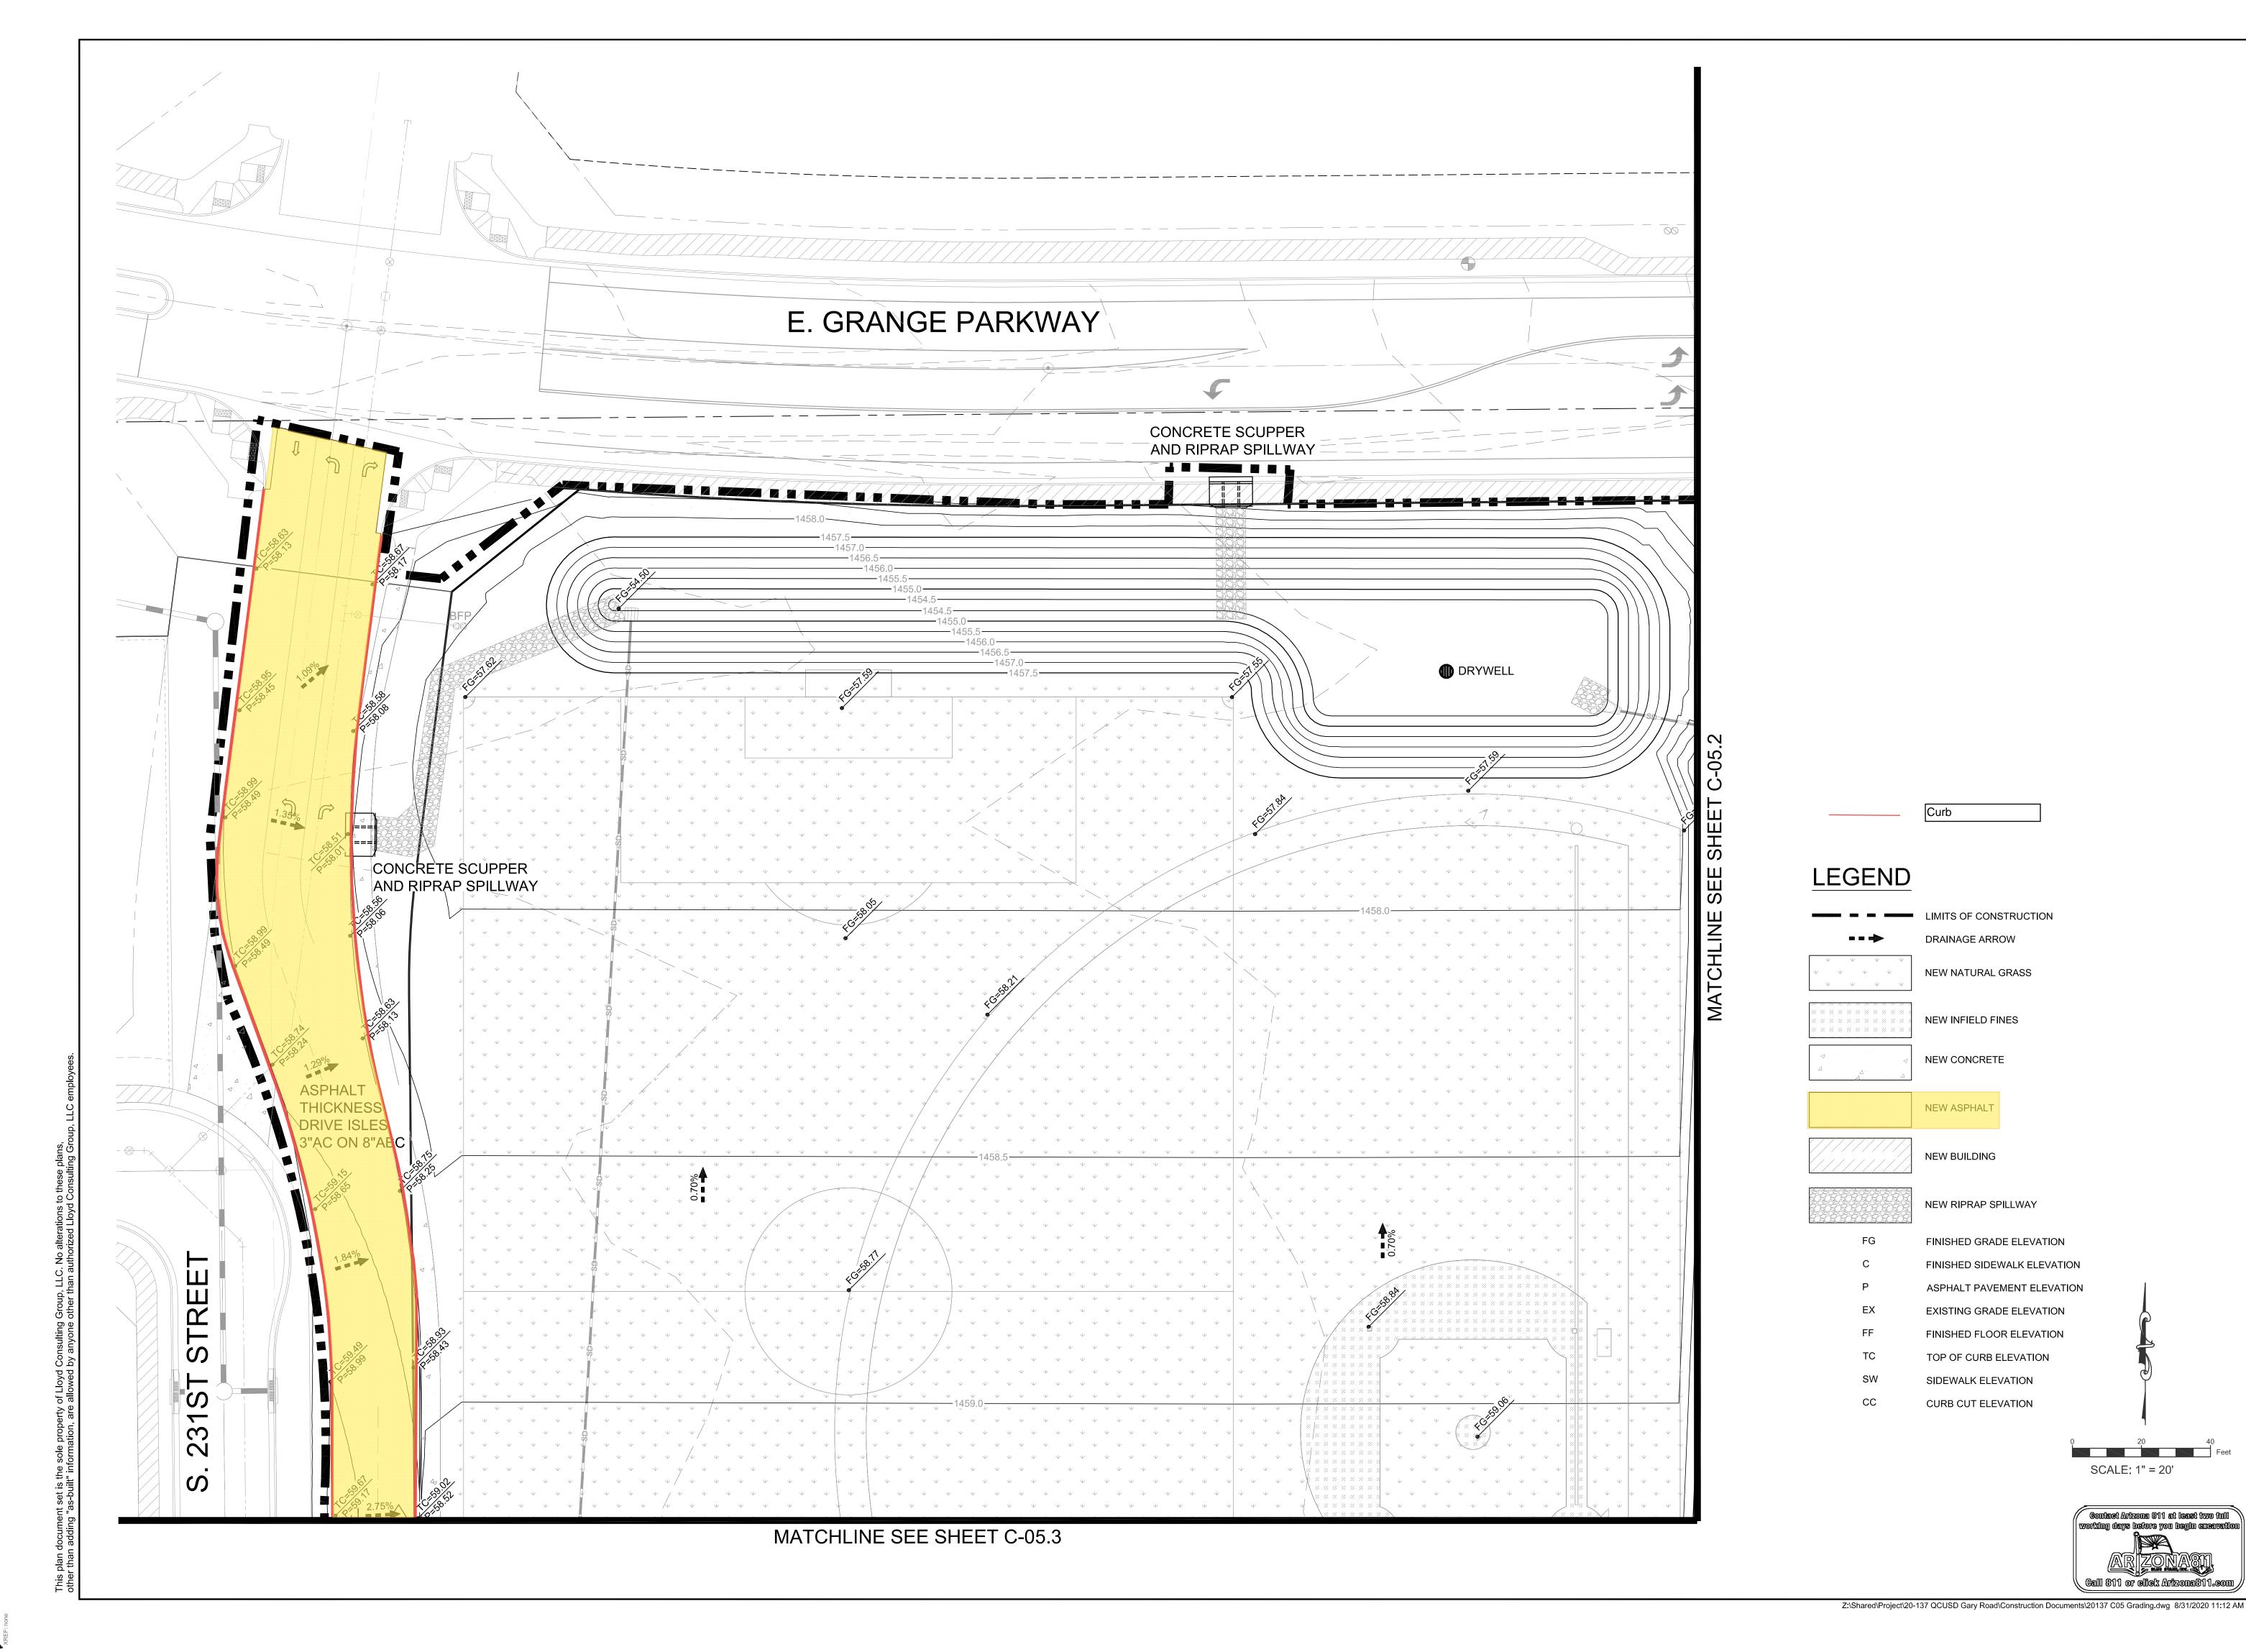
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Call 811 or elick Arizona811.com

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APRONA, U.S.A

REV.

QUEEN CREEK USD HARVEST SCHOOL

> N. GARY ROAD QUEEN CREEK, AZ

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 JLP

 DATE:
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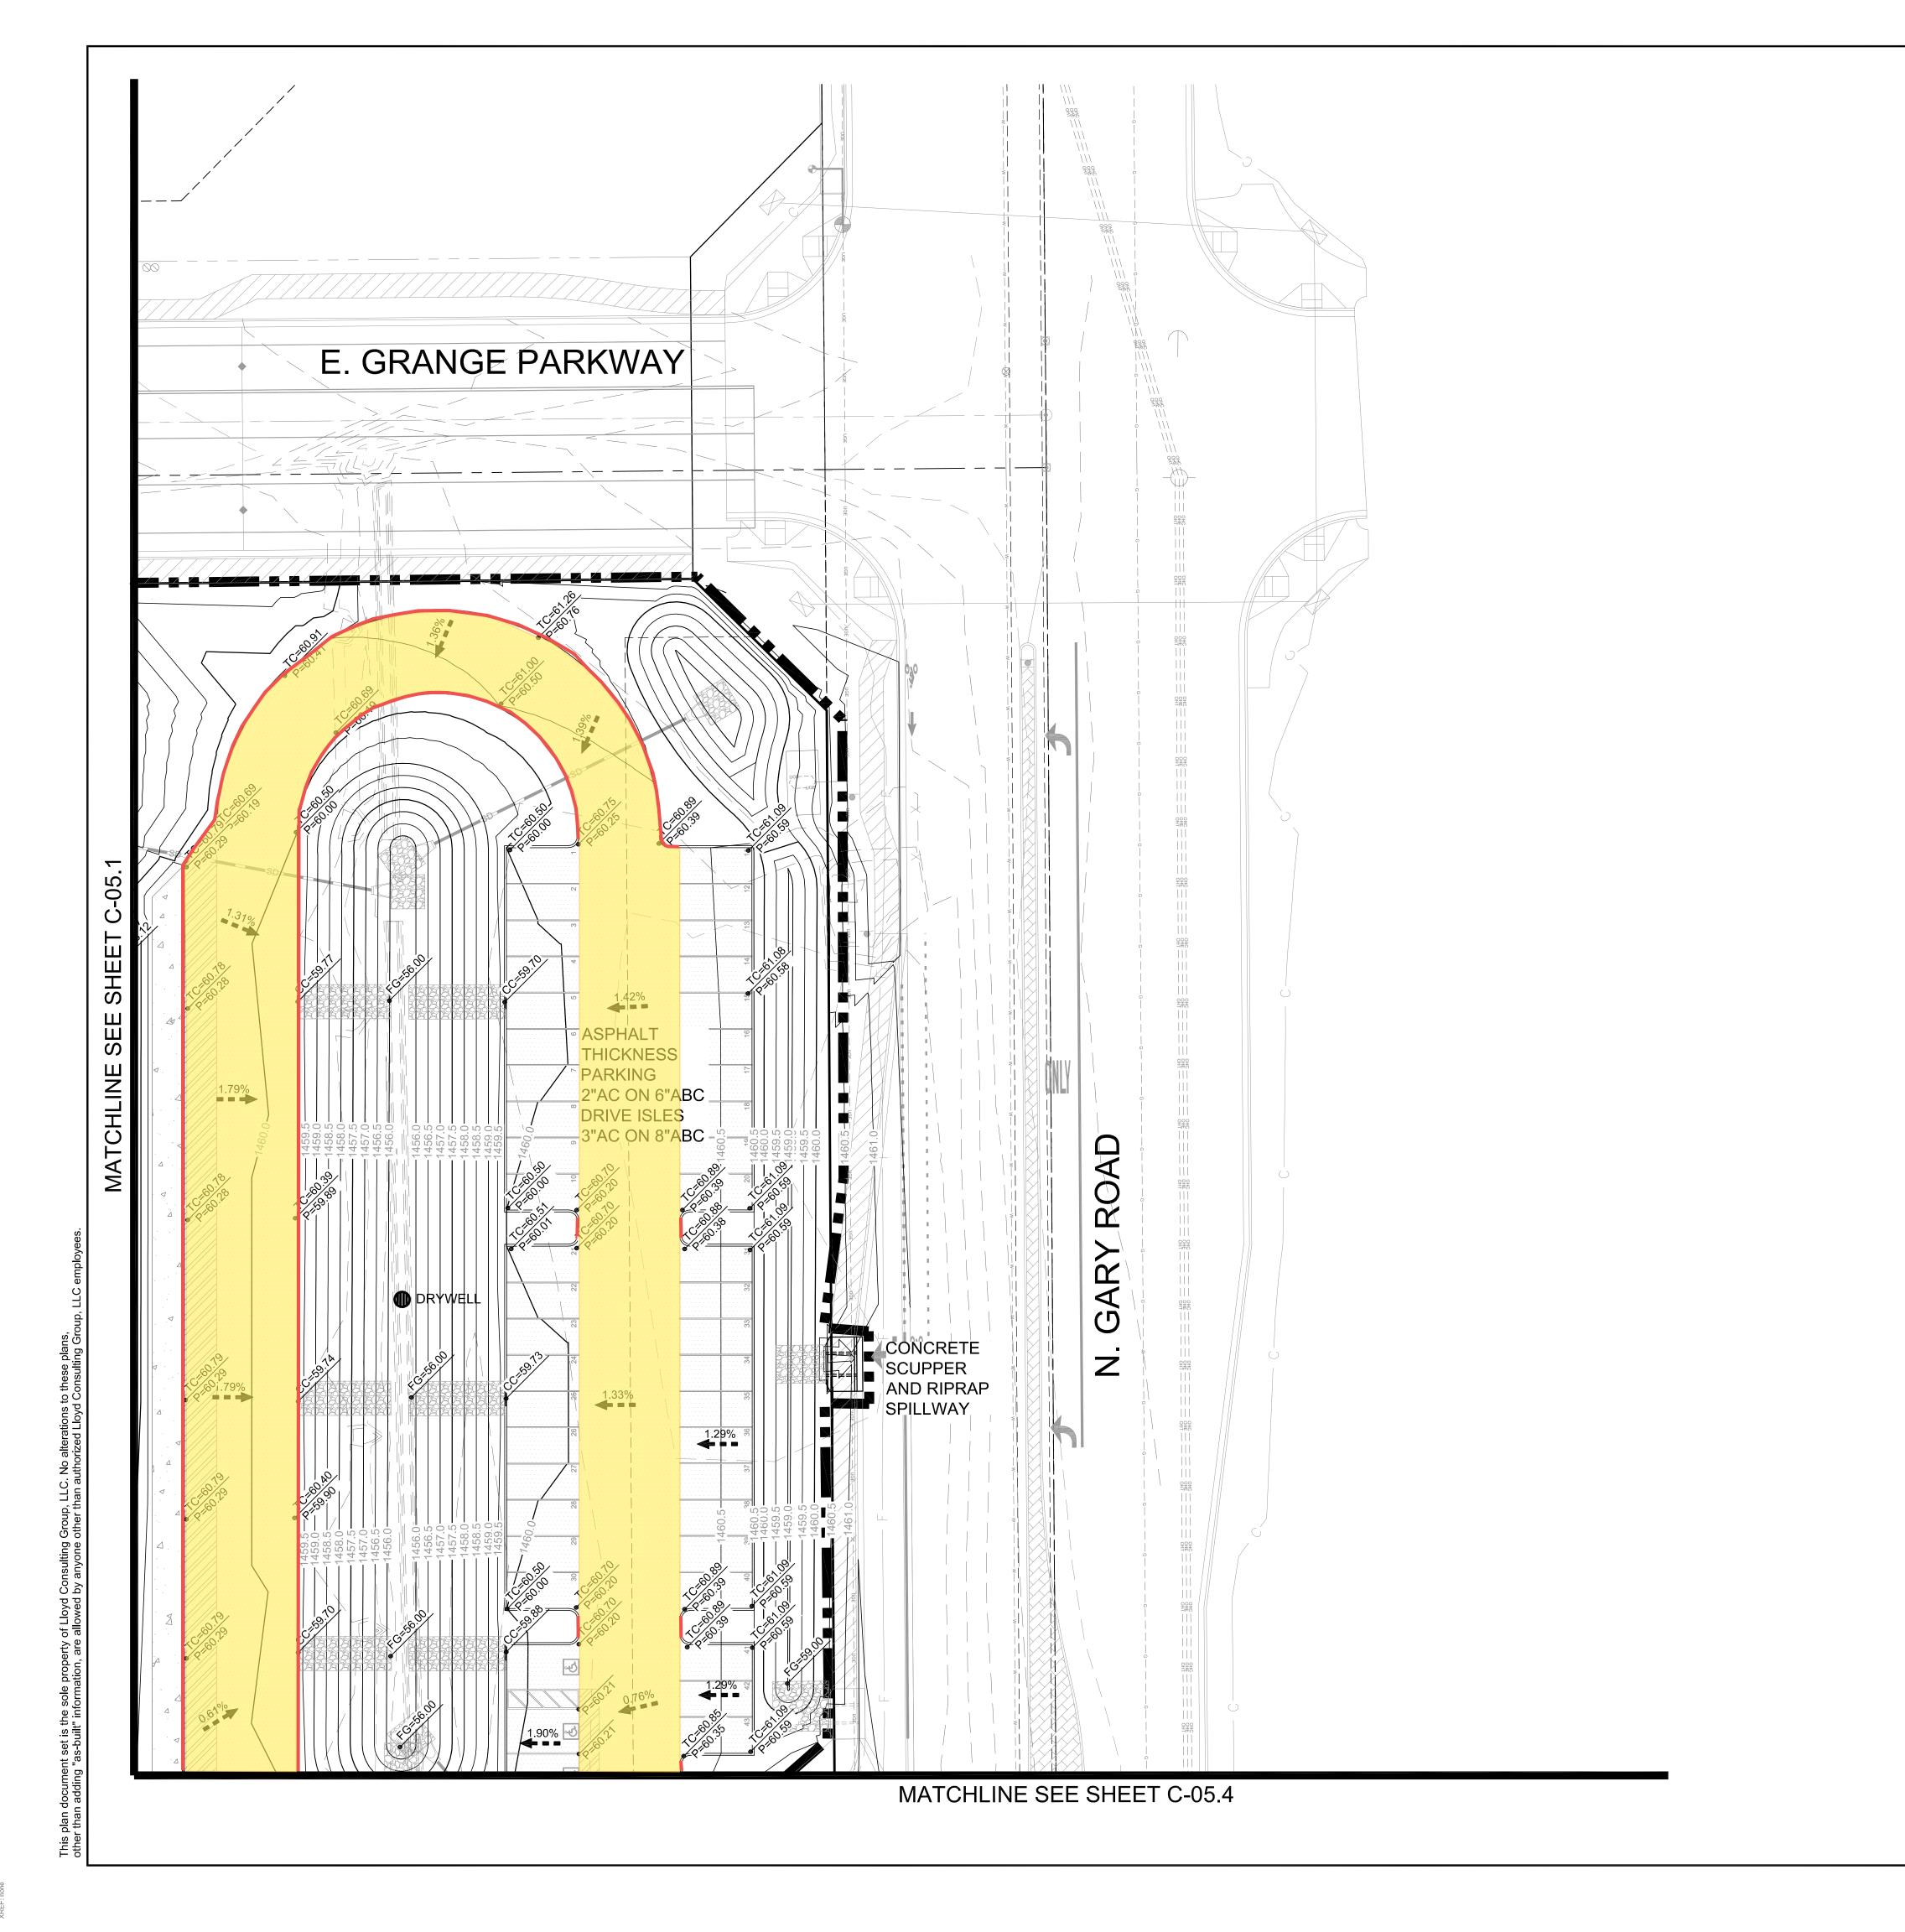
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 PROJ.
 20-137

 SCALE:
 1" = 20'

GRADING PLAN

C-05.1





7349 N. VIA PASEO DEL SUR SUITE 515-324 SCOTTSDALE, ARIZONA 85258 PH 602.635.4226

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Feet

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Curb

LIMITS OF CONSTRUCTION

DRAINAGE ARROW

NEW NATURAL GRASS

NEW INFIELD FINES

**NEW CONCRETE** 

**NEW ASPHALT** 

**NEW BUILDING** 

NEW RIPRAP SPILLWAY

FINISHED GRADE ELEVATION

EXISTING GRADE ELEVATION

FINISHED FLOOR ELEVATION

TOP OF CURB ELEVATION

SIDEWALK ELEVATION

CURB CUT ELEVATION

FINISHED SIDEWALK ELEVATION

ASPHALT PAVEMENT ELEVATION

LEGEND

ACTOR SIONAL SERVICE SIONAL SERVICE

REV.

QUEEN CREEK USD

HARVEST SCHOOL

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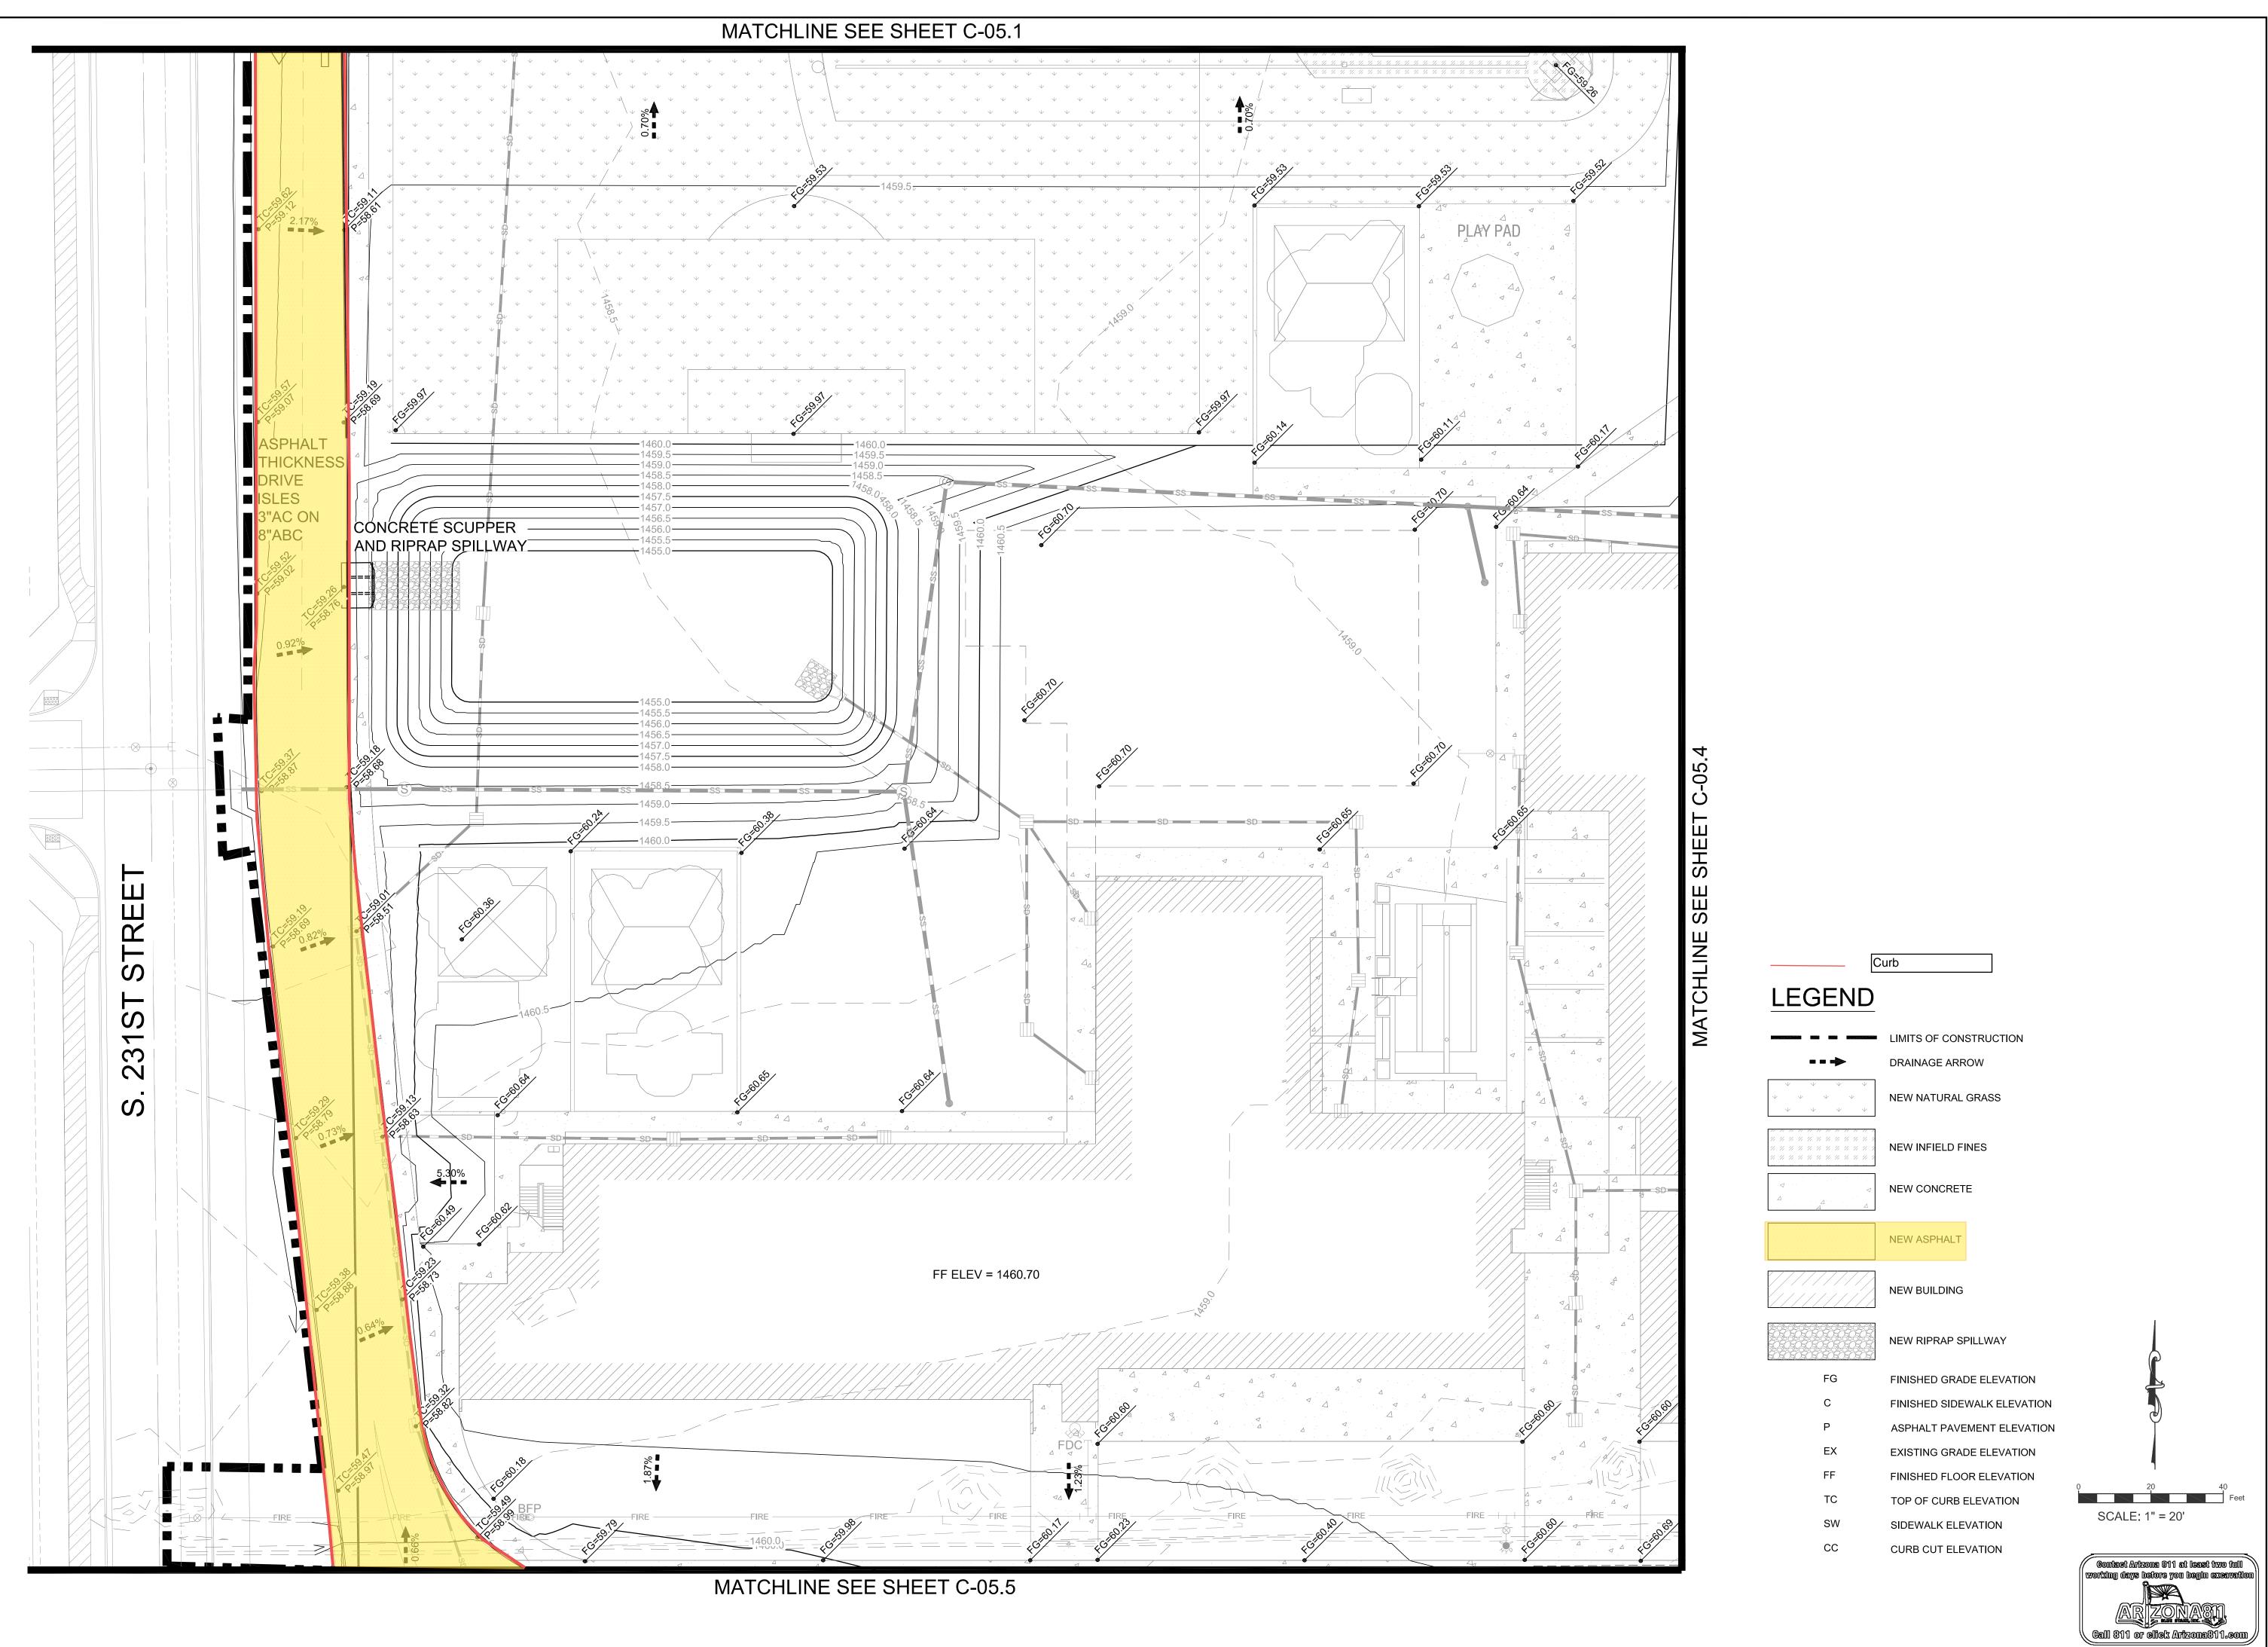
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QUEEN CREEK USD HARVEST SCHOOL

> N. GARY ROAD QUEEN CREEK, AZ

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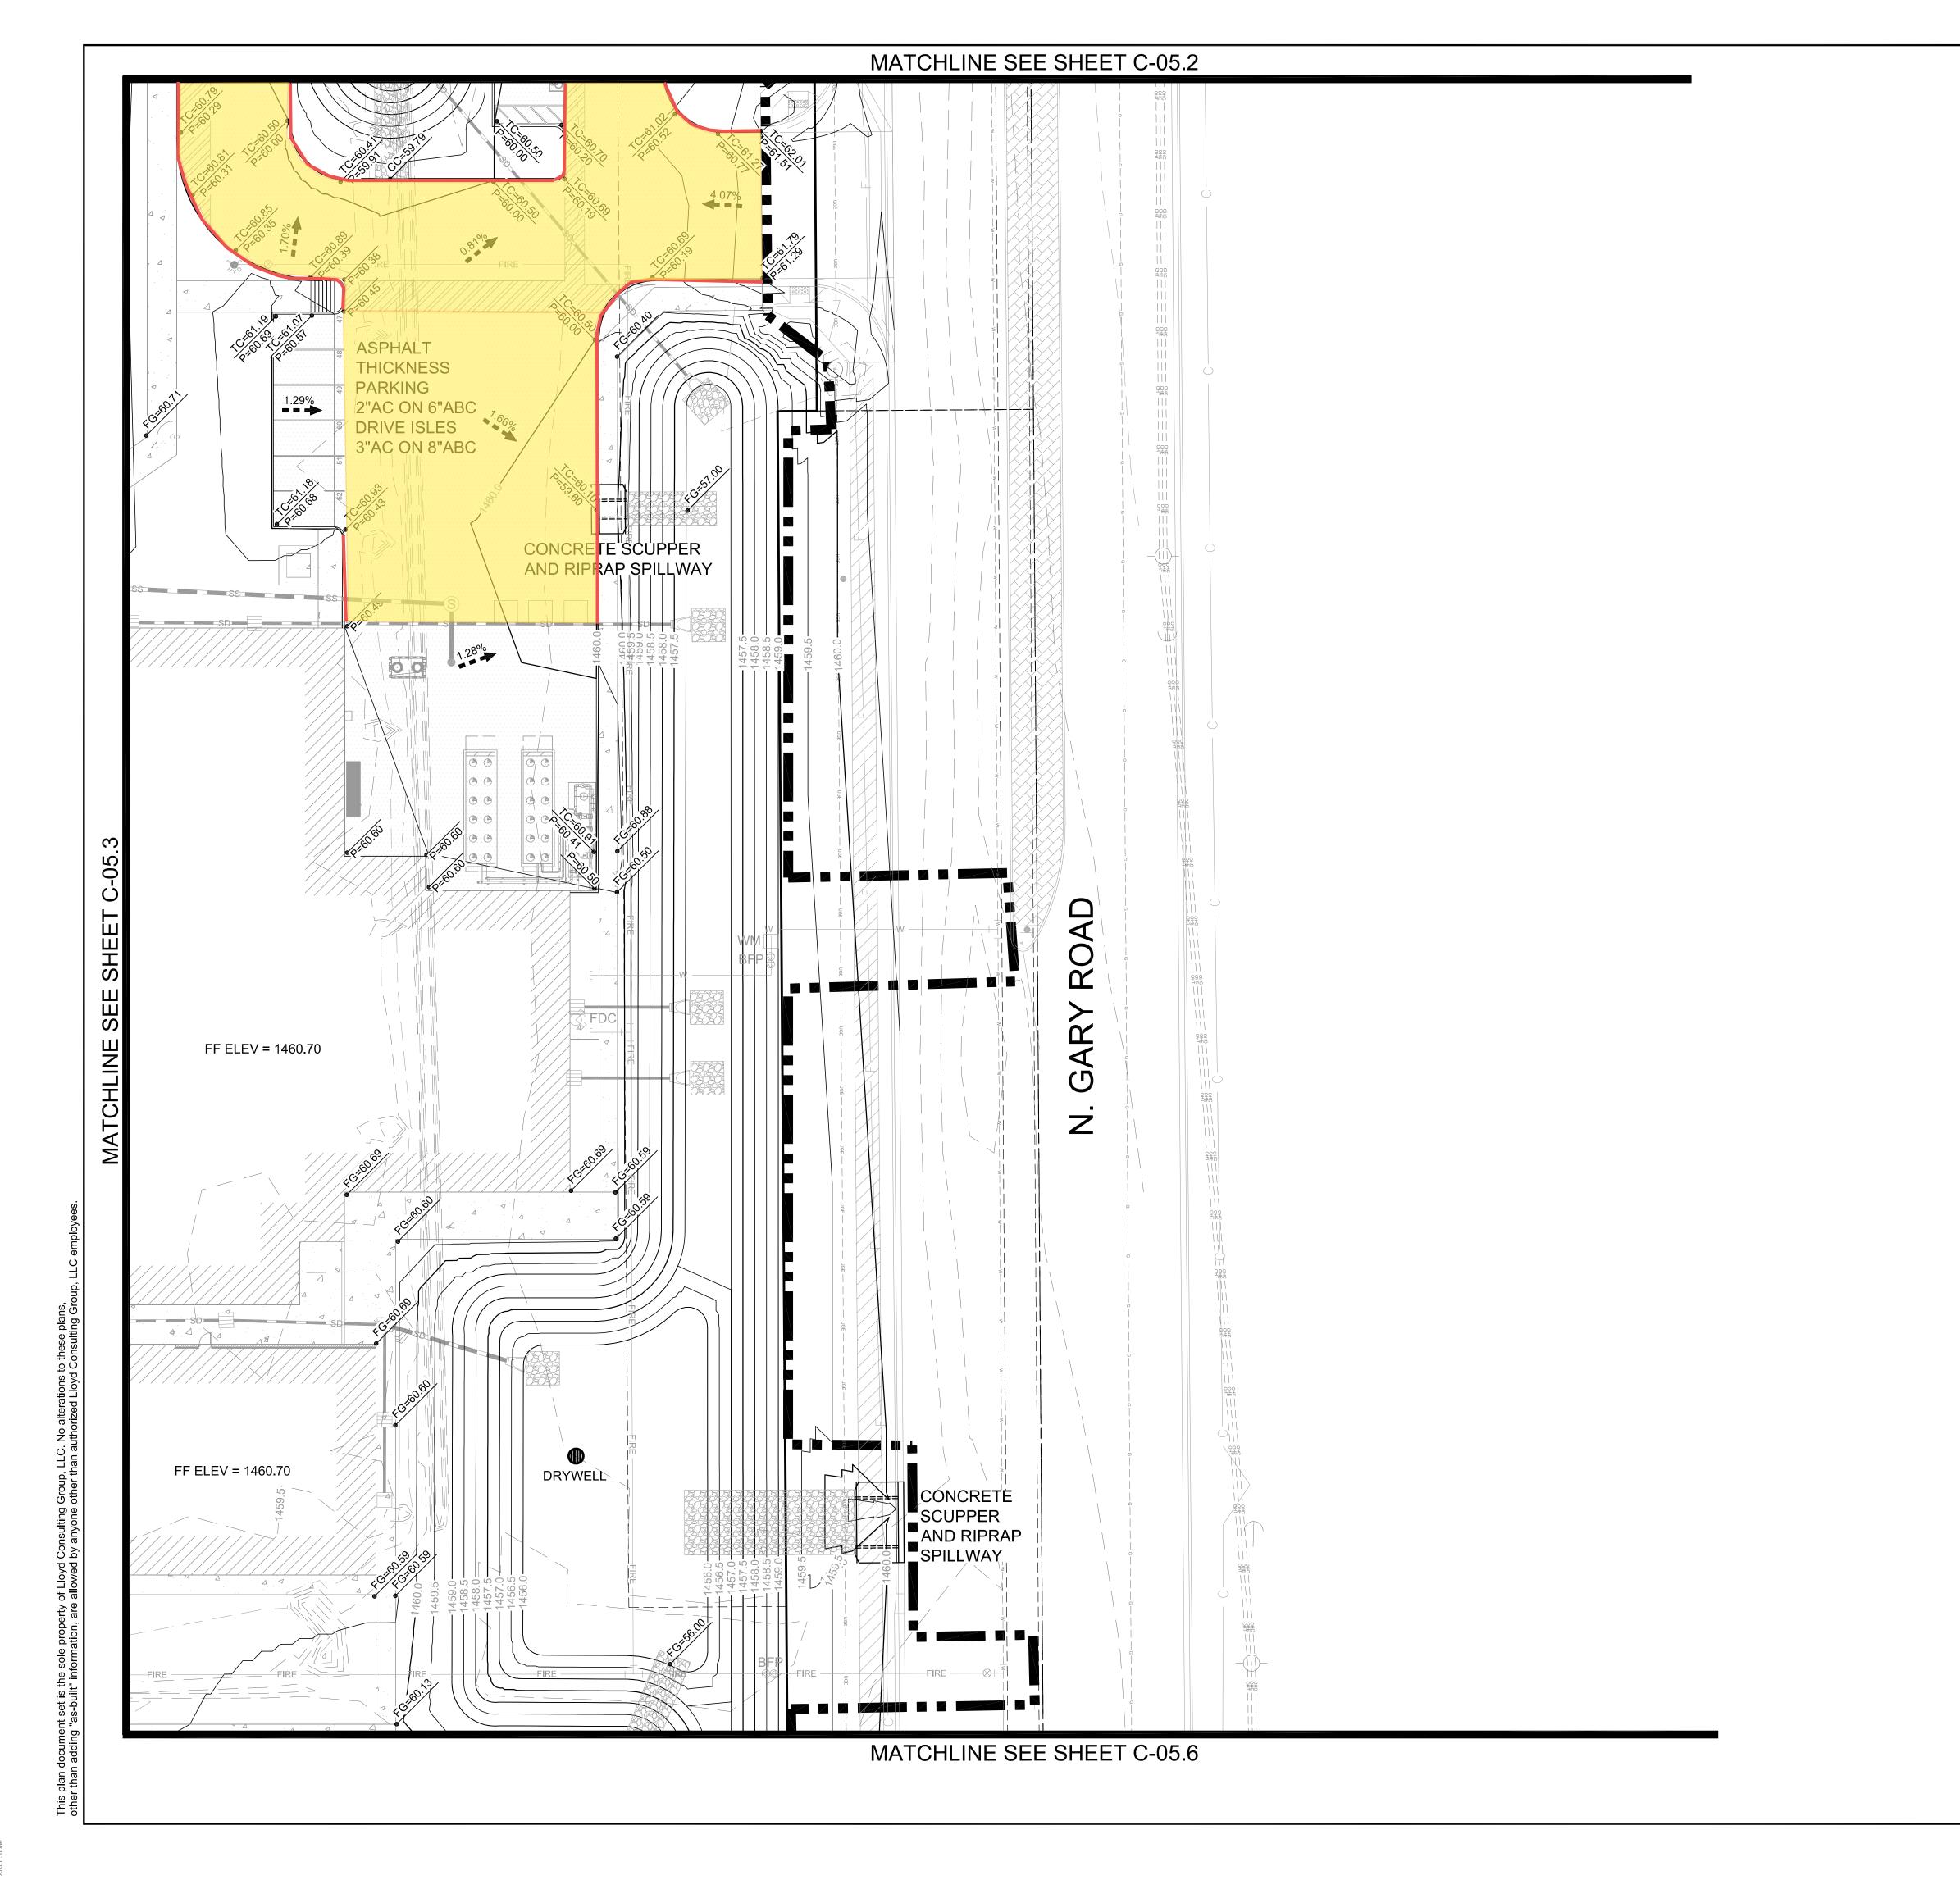
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SUITE 515-324 SCOTTSDALE, ARIZONA 85258 PH 602.635.4226

### FOR PRELIMINARY

LIMITS OF CONSTRUCTION DRAINAGE ARROW NEW NATURAL GRASS NEW INFIELD FINES

**NEW ASPHALT** 

LEGEND

NEW RIPRAP SPILLWAY

**NEW CONCRETE** 

**NEW BUILDING** 

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FG	FINISHED GRADE ELEVATION
С	FINISHED SIDEWALK ELEVAT
Р	ASPHALT PAVEMENT ELEVA

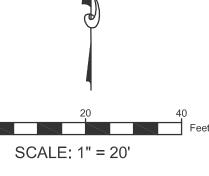
EXISTING GRADE ELEVATION

FINISHED FLOOR ELEVATION TOP OF CURB ELEVATION

SIDEWALK ELEVATION

CURB CUT ELEVATION

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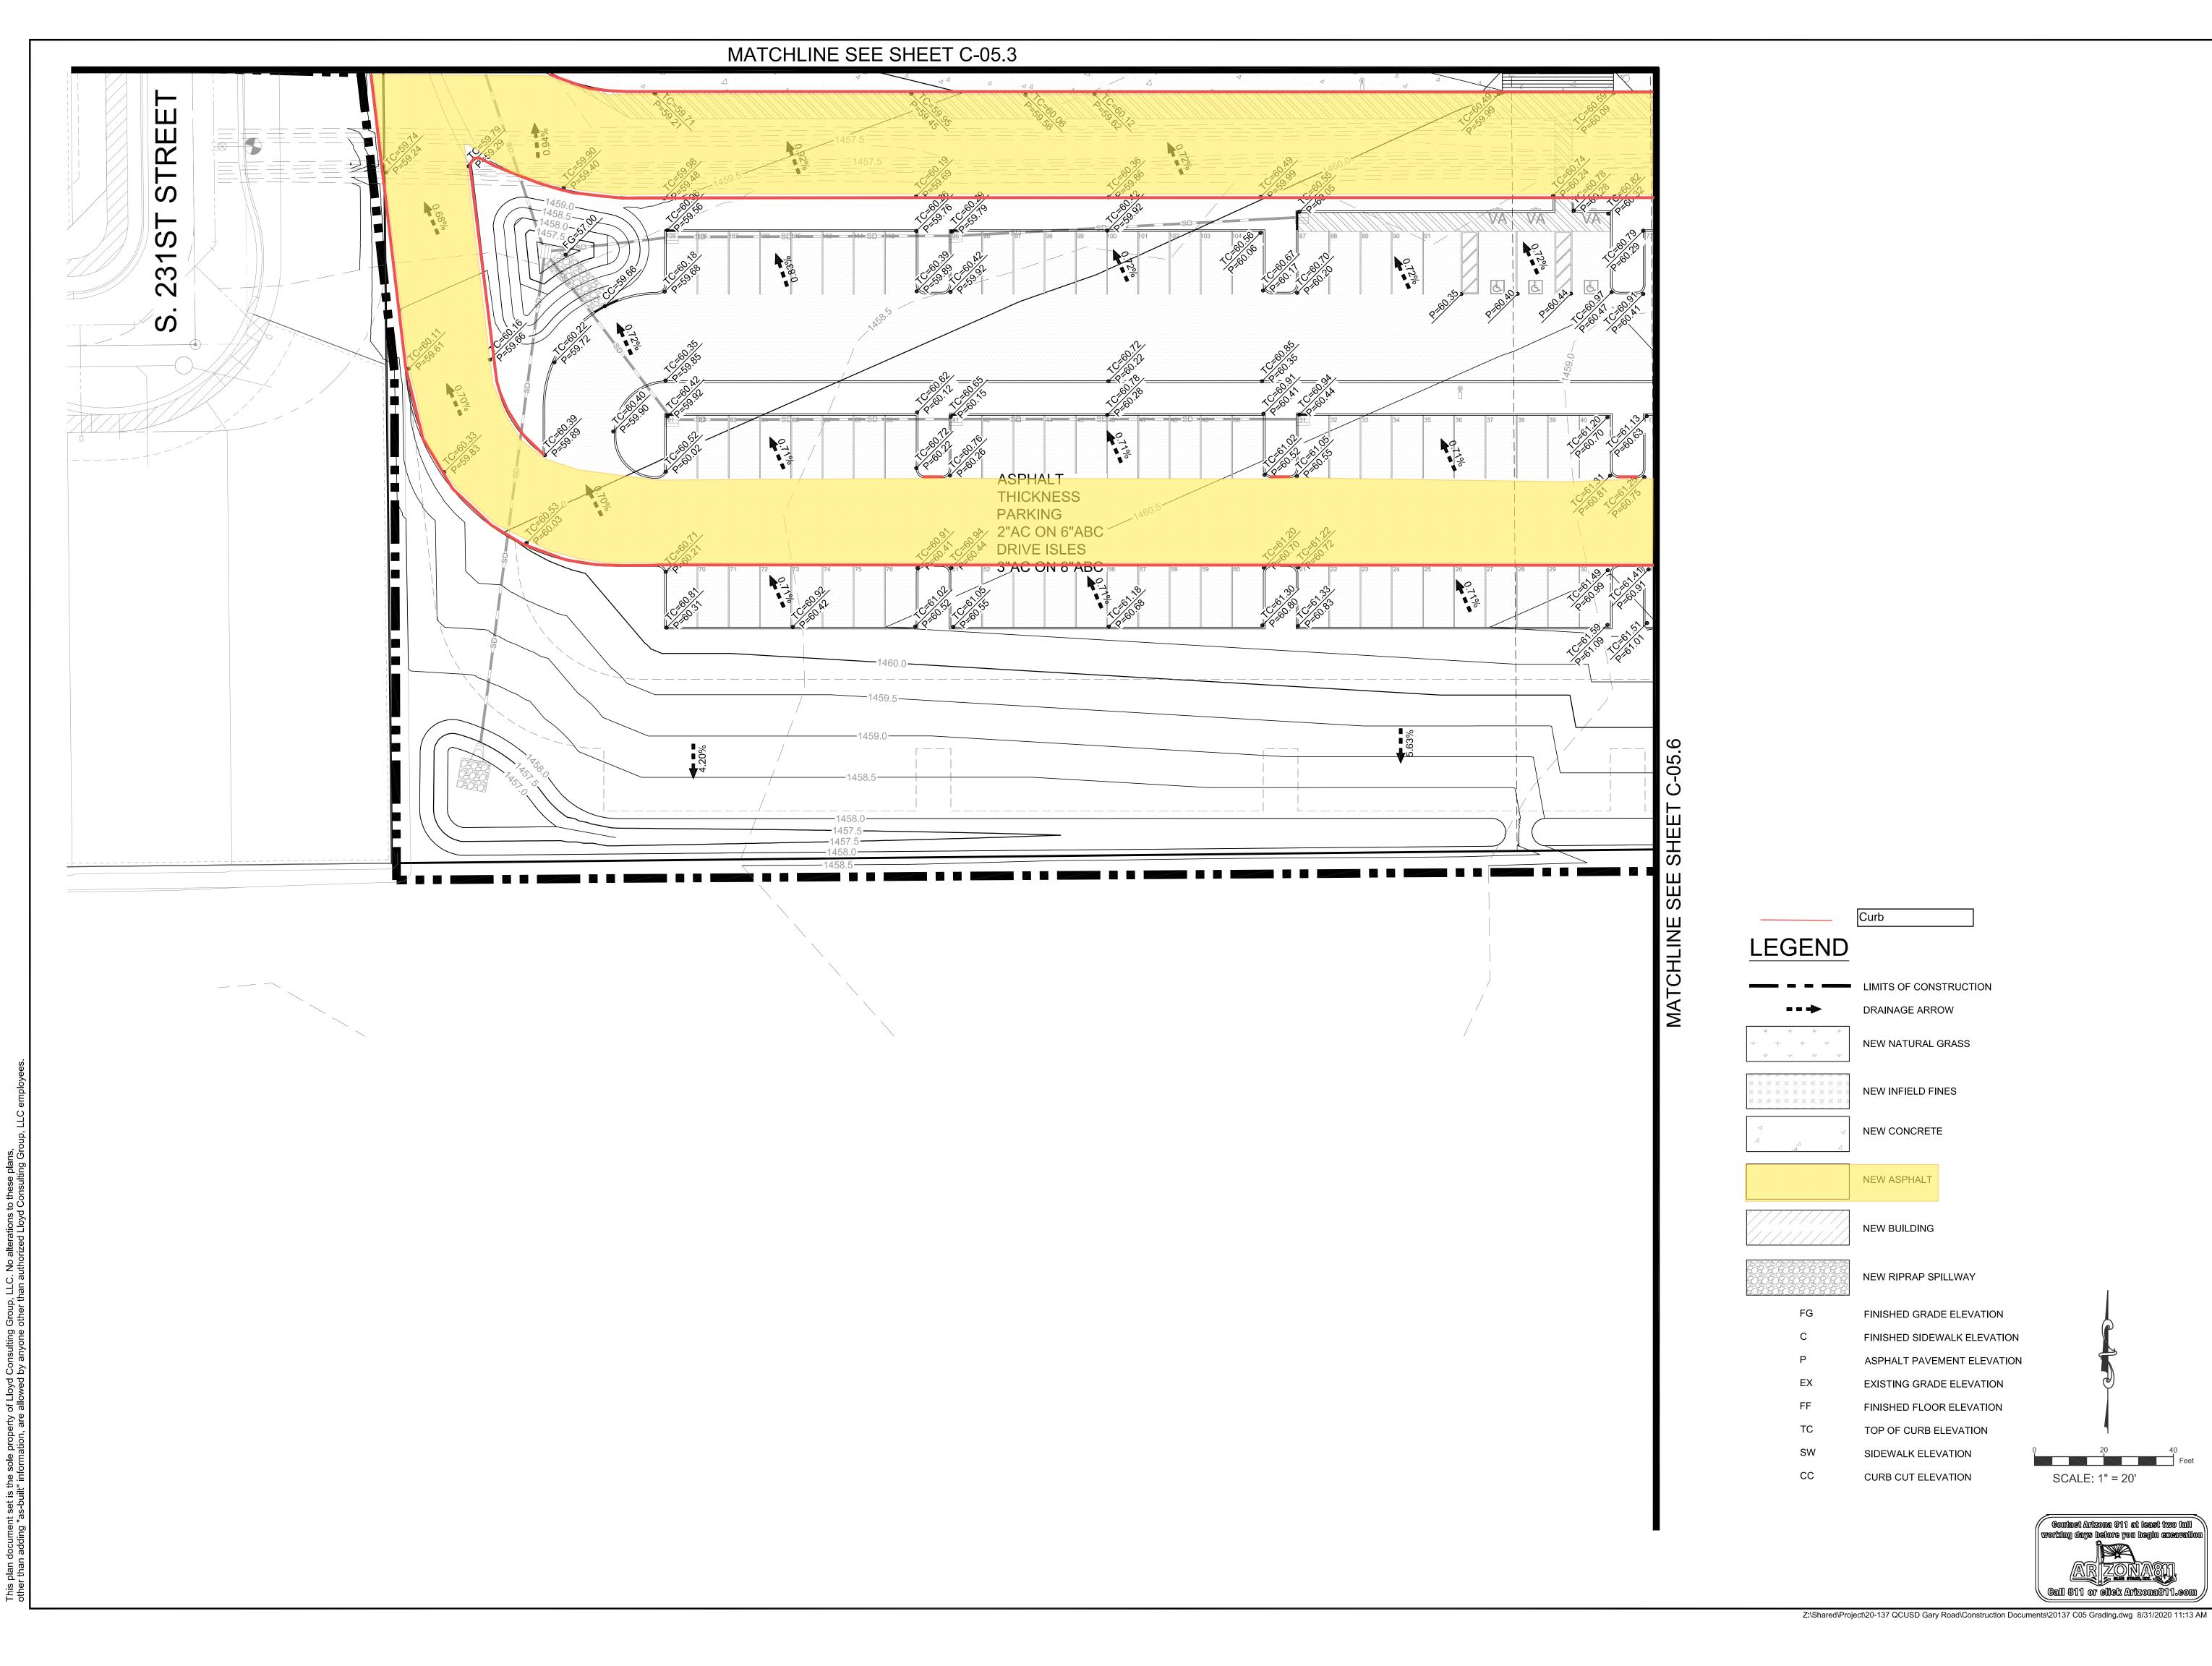
QUEEN CREEK USD HARVEST SCHOOL

> N. GARY ROAD QUEEN CREEK, AZ

JLP DESIGNED: Aug 31, 2020 DATE: TML DRAWN: 20-137 PROJ. SCALE: 1" = 20'

> GRADING PLAN DWG. NO.

C-05.4





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EV.

QUEEN CREEK USD

N. GARY ROAD QUEEN CREEK, AZ

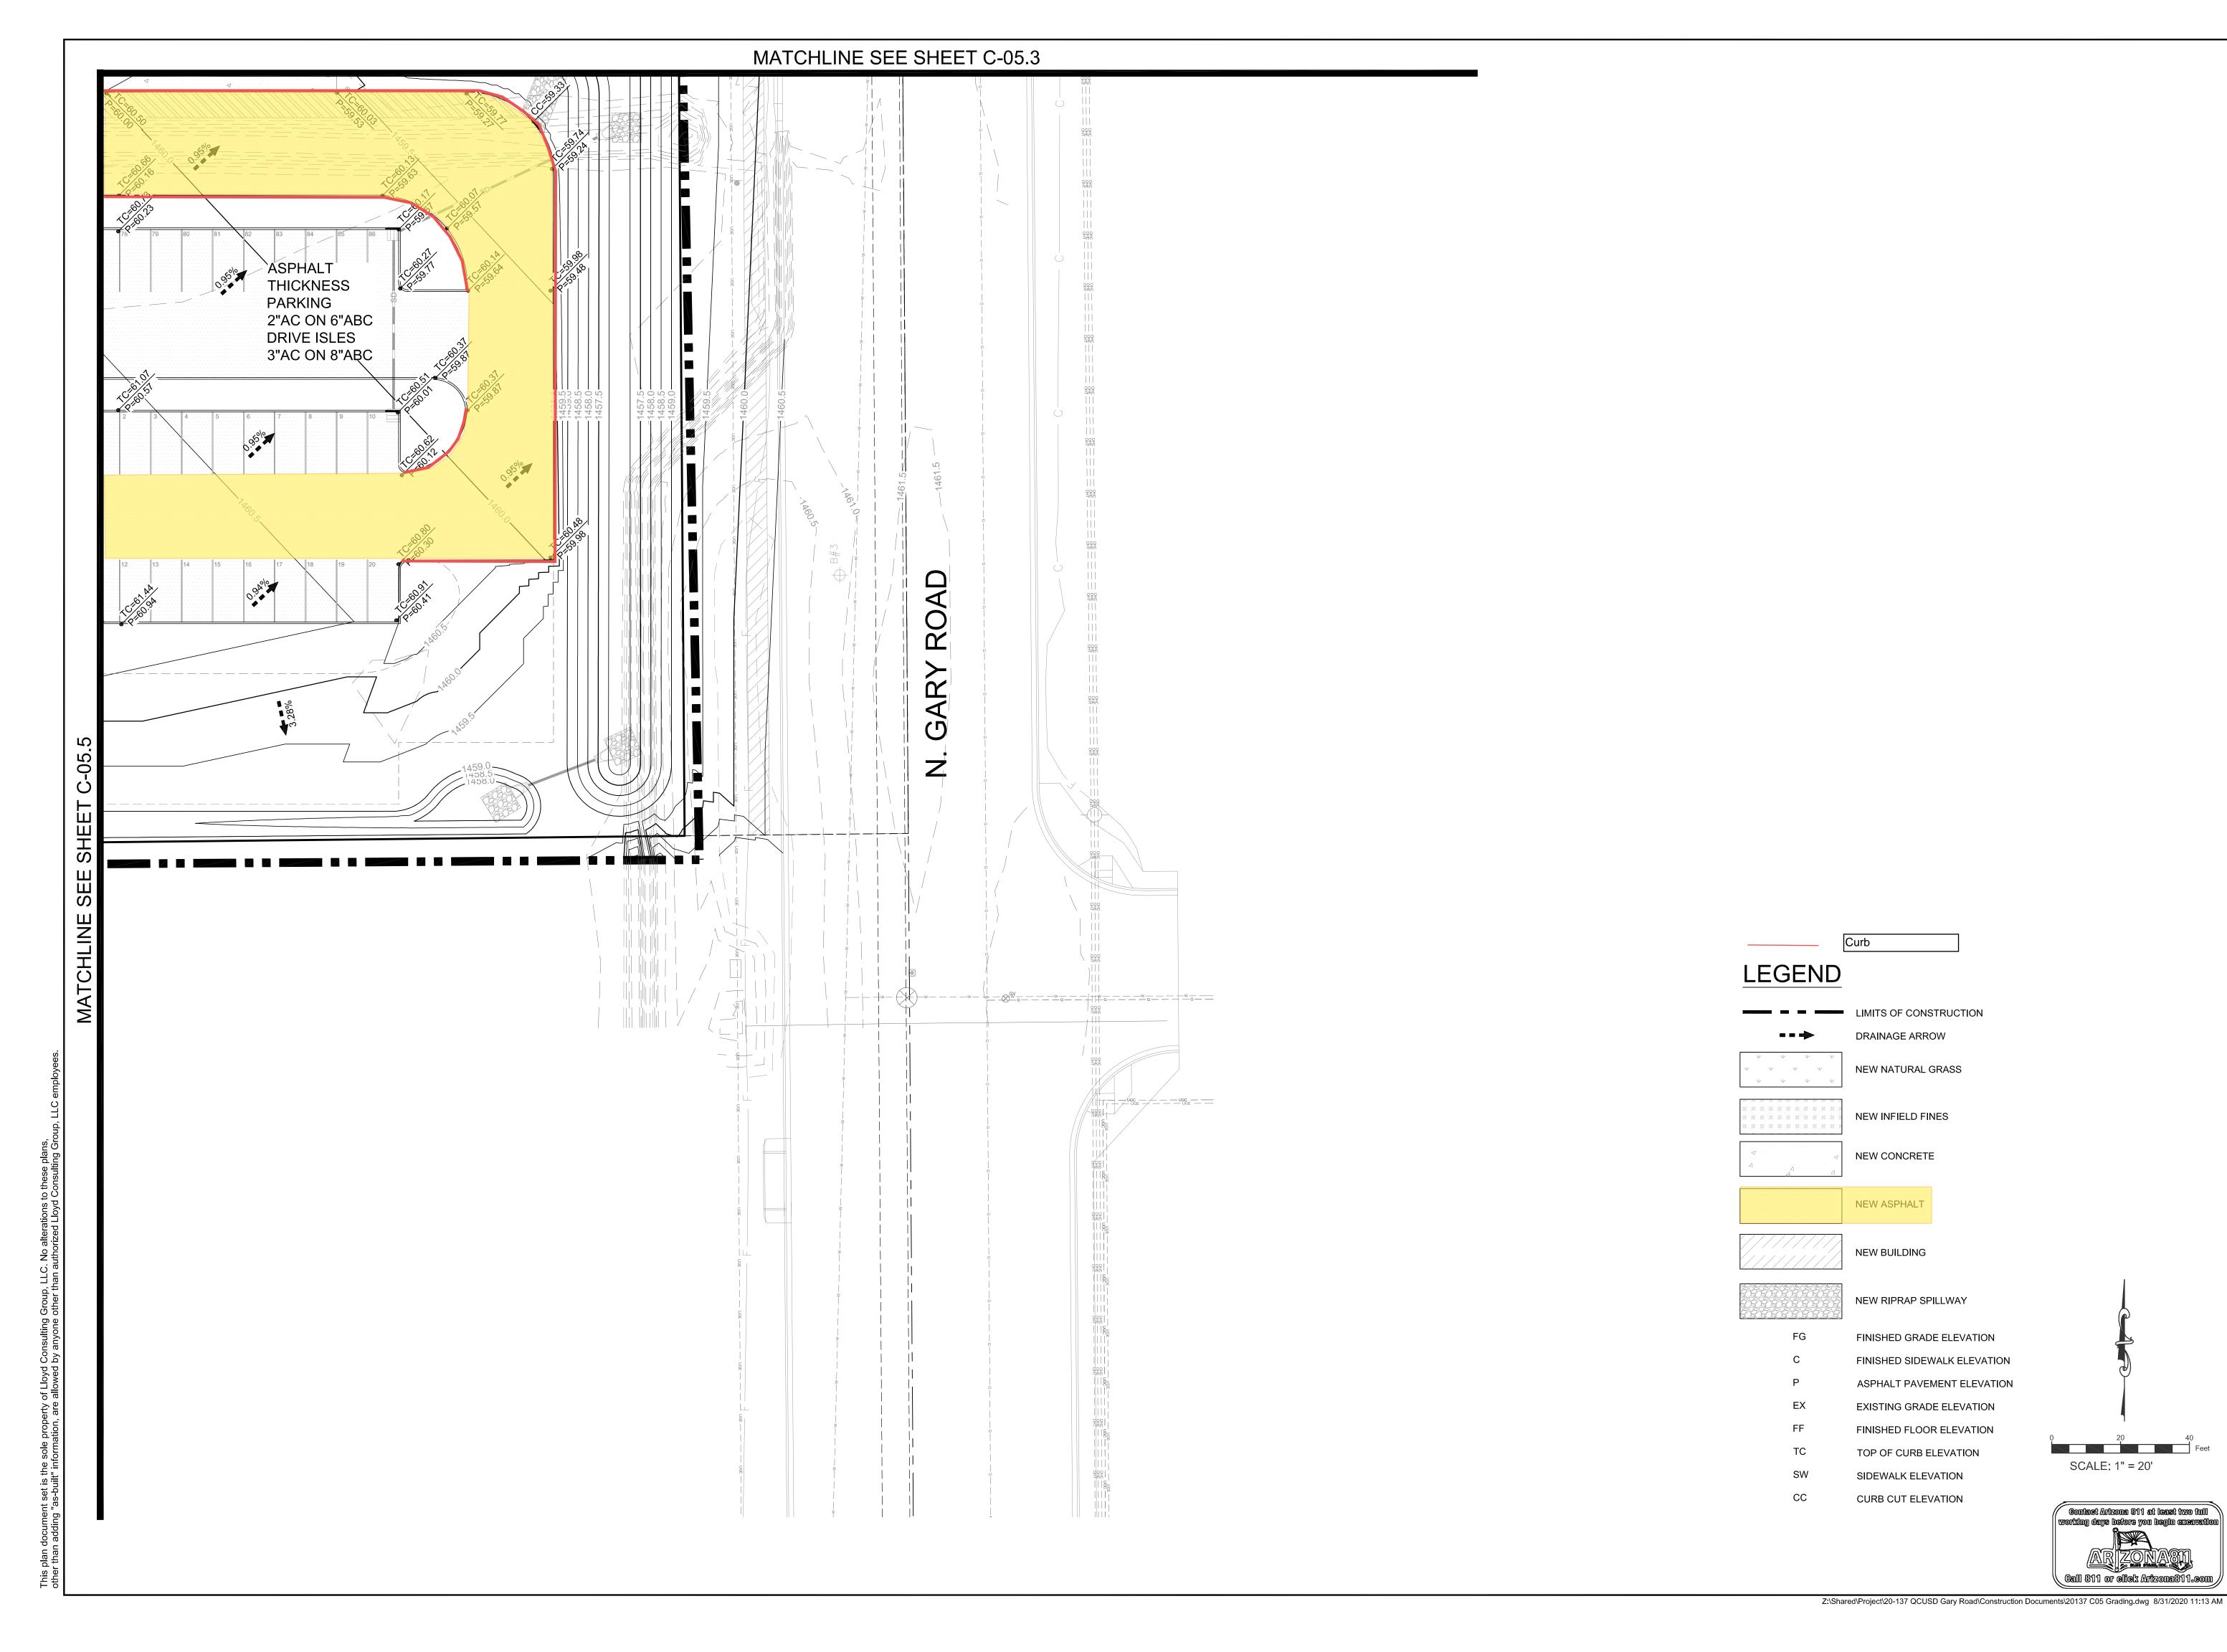
HARVEST SCHOOL

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HARVEST SCHOOL

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SCALE: 1" = 20' GRADING PLAN Combact Arizona 311 at least two full working days before you begin excavation

Feet

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